Service Manual

SERVICE PARTS & DIAGRAMS

BENDPAK

MD-6XP

PRODUCT SKU **5175730**

DRAWING Nº

5260652

CATEGORY

Mid-Rise Scissor Lift

REV

Version E

DATE

03.08.2022



This guide is a troubleshooting reference used for maintaining and servicing your Bend Pak product. It provides comprehensive information on identifying serviceable parts and components and assists in troubleshooting problems and performing assembly /disassembly procedures.



1645 Lemonwood Drive Santa Paula, CA 93060 USA Toll Free US/Canada: 1-800-253-2363 Fax: 1-805-933-9160 info@bendpak.com

Customer Service Desk / Warranty

Customer Service Representatives
Office Tel: 1-805-933-9970
Toll Free US/Canada: 1-800-253-2363
Fax: 1-805-933-9160
customerservice@bendpak.com

Parts Orders

Customer Service Representatives Office Tel: 1-805-933-9970 Toll Free US/Canada: 1-800-253-2363 Fax: 1-805-933-9160 parts@bendpak.com


Domestic Sales & Service


USA Sales Representatives Office Tel: 1-805-933-9970 Toll Free US/Canada: 1-800-253-2363 Fax: 1-805-933-9160 sales@bendpak.com


International Sales & Service


Office Tel: 1-805-933-9970 Exports Dept: 1-805-933-9970 EXT. 192 Ext. Toll Free US/Canada: 1-800-253-2363 Fax: 1-805-933-9160 bpkexports@bendpak.com



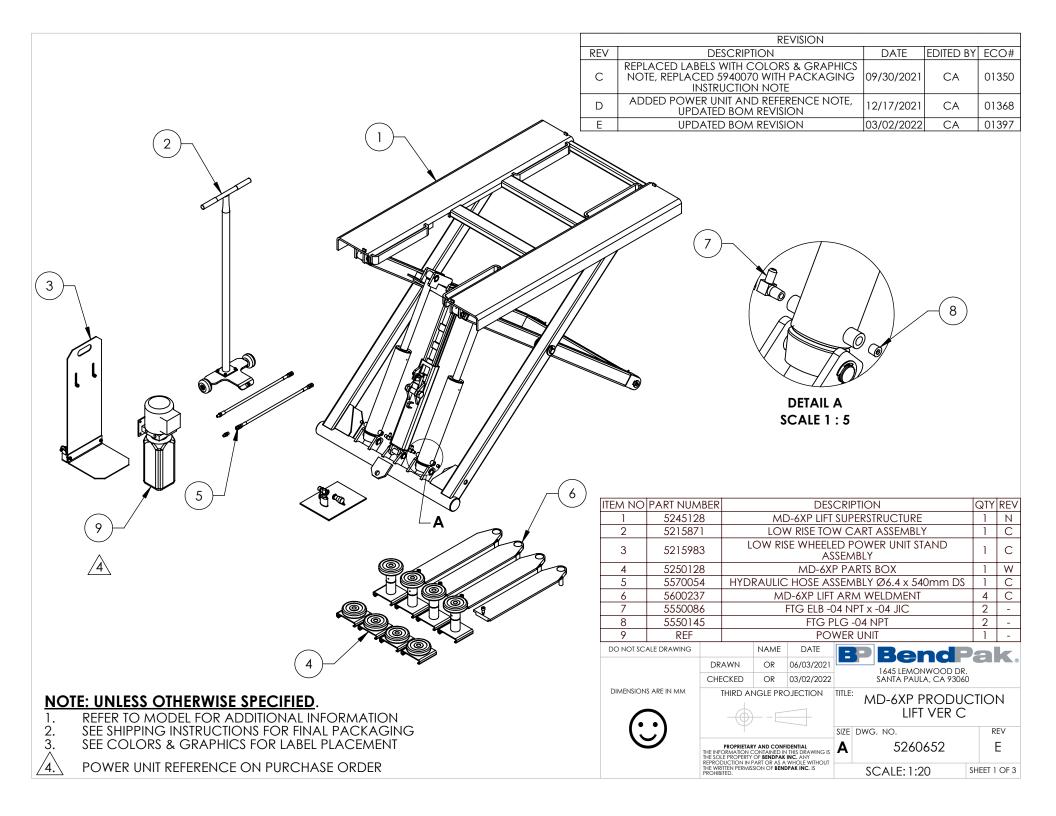

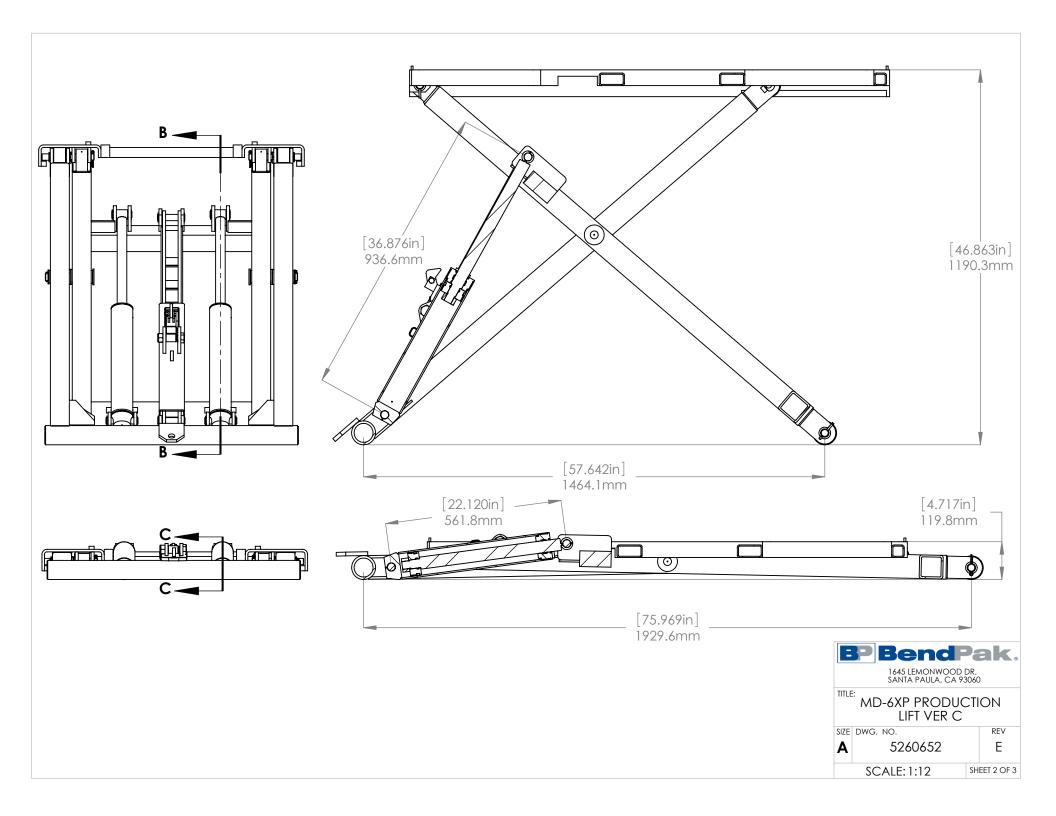

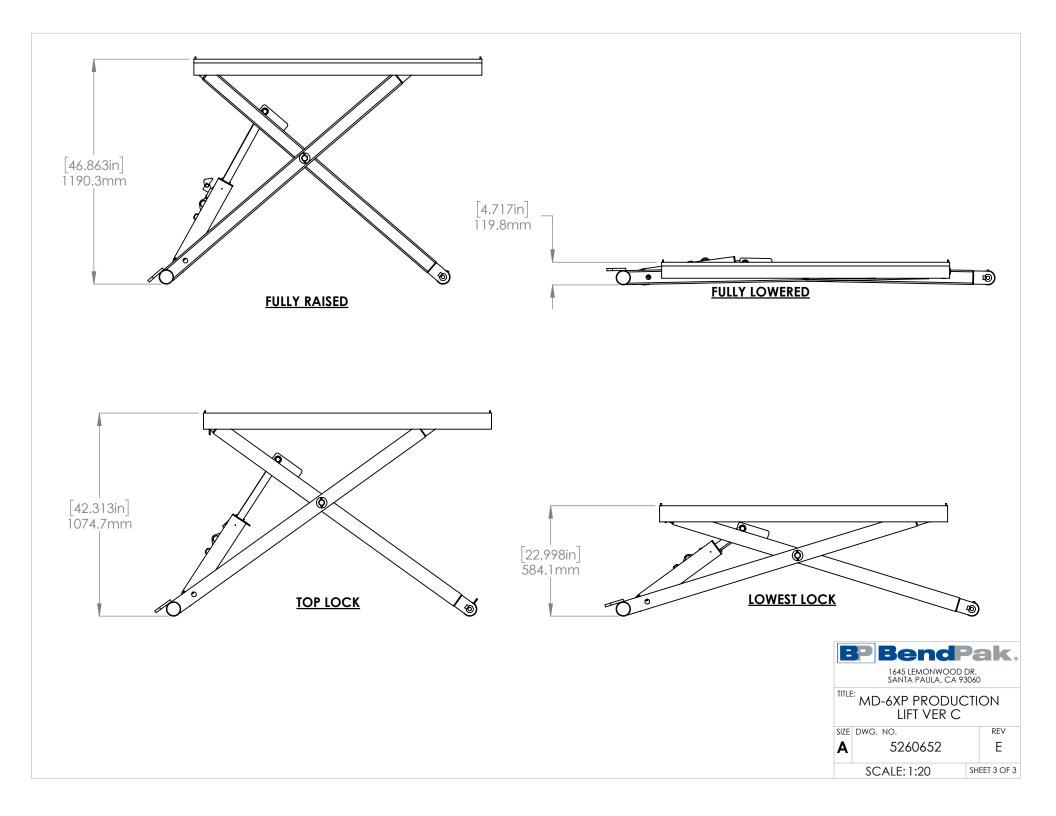

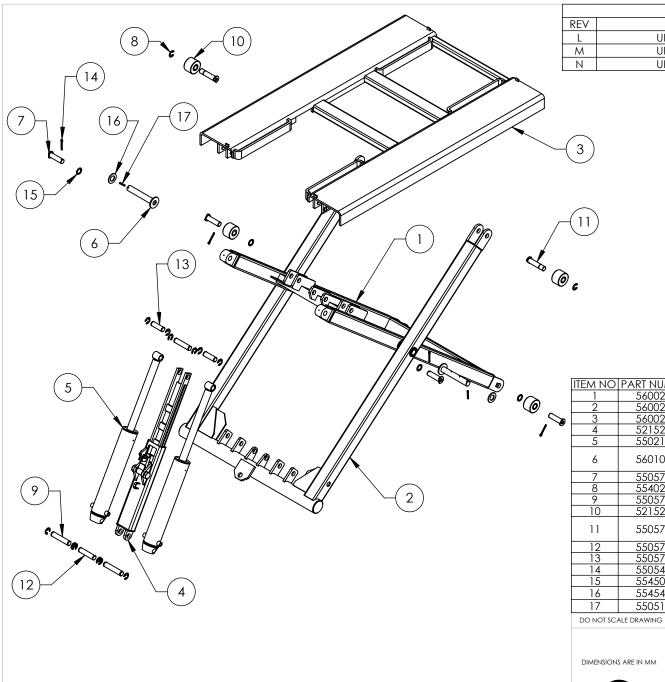

	REVISION			
REV	DESCRIPTION	DATE	EDITED BY	ECO#
L	UPDATED BOM REVISION	06/16/2016	TS	00766
М	UPDATED BOM REVISION	08/03/2017	TS	00861
Ν	UPDATED BOM REVISION	06/03/2021	OR	01306

ITEM NO	PART NUMBER	DESCRIPTION	QTY	REV
1	5600238	MD-6XP INNER ARM WELDMENT	1	С
2	5600240	MD-6XP OUTER ARM WELDMENT	1	N
3	5600239	MD-6XP COVER WELDMENT	1	О
4	5215253	MD-6XP SAFETY ASSEMBLY	1	С
5	5502175	CYLINDER ASSEMBLY Ø3.0 x 15	2	F
6	5601085	DMR-6/MD-6XP MAIN ARM PIVOT PIN WELDMENT	2	Α
7	5505723	DMR-6/MD-6XP INNER ARM PIN WELDMENT	4	D
8	5540275	E RING Ø25mm OD DIN 6799 0250	14	
9	5505722	MD-6XP CYLINDER PIN, LOWER	2	Α
10	5215265	DMR-6/MD-6XP ROLLER ASSEMBLY	4	С
11	5505719	DMR-6/MD-6XP OUTER SCISSOR ROLLER PIN WELDMENT	2	В
12	5505720	DMR-6/MD-6XP SAFETY PIN	2	Α
13	5505721	DMR-6/MD-6XP CYLINDER PIN, UPPER	2	Α
14	5505400	Ø6 x 50mm COTTER PIN	4	
15	5545001	WASHER 25mm x 37mm	4	
16	5545415	WASHER M30 x 56 FLAT	2	
17	5505106	SPRING PIN M6 x 50	2	-

DATE

02/19/2009

DIMENSIONS ARE IN MM

NEXT ASSEMBLY

5260169



NAME

TM

DRAWN

CHECKED

MD-6XP LIFT SUPERSTRUCTURE


1645 LEMONWOOD DR. SANTA PAULA, CA 93060

PROPRIETARY AND CONFIDENTIAL
THE INFORMATION CONTAINED IN THIS DRAWING IS
THE SOLE PROPERTY OF BENDFAK INC. ANY
REPRODUCTION IN PART OR AS A WHOLE WITHOUT
THE WRITTEN PERMISSION OF BENDPAK INC. IS
PROHIBITED.


SIZE DWG. NO. REV 5245128 Ν SCALE: 1:20 SHEET 1 OF 1

NOTE: UNLESS OTHERWISE SPECIFIED.

- SEE SHIPPING INSTRUCTIONS FOR FINAL PACKAGING
- ASSEMBLE ITEMS AS SHOWN

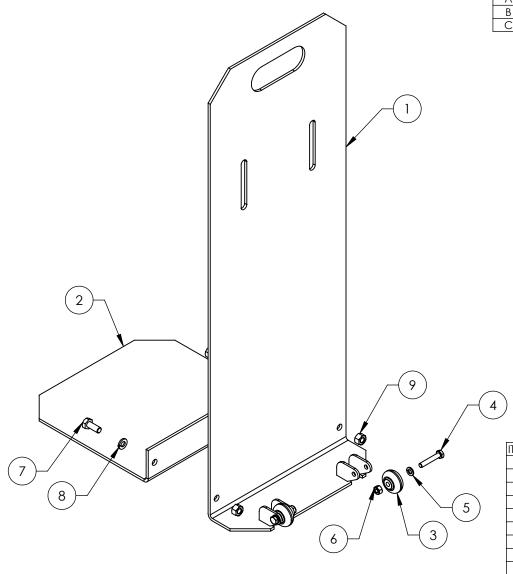

	REVISION						
REV	DESCRIPTION	DATE	EDITED BY	ECO#			
Α	PRODUCTION RELEASE	08/11/2020	TM	01188			
В	UPDATED BOM REVISION AND NEXT ASSEMBLY	12/17/2021	CA	01368			
С	UPDATED BOM REVISION	03/02/2022	CA	01397			

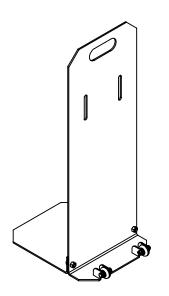

ISOMETRIC VIEW FOR REFERENCE ONLY DO NOT SCALE

ITEM NO	PART NUMBER	DESCRIPTION	QTY	REV
1	5601407	LOW RISE POWER UNIT STAND WELDMENT	1	D
2	5737141	LOW RISE POWER UNIT STAND EXTENSION PLATE	1	В
3	5716192	QUICKJACK POLYURETHANE WHEEL	2	Е
4	5530027	HHB M6 x 1.0 x 35	2	
5	5545026	WASHER M6 x Ø12 SL	2	
6	5535357	NUT M6 x 1.0 NL	2	
7	5530304	HHB M8 x 1.25 x 20mm	2	
8	5545202	WASHER M8 x Ø15 SL	2	
9	5535001	NUT M8 x 1.25 NL	2	

DO NOT SCALE DRAWING		NAME	DATE
	DRAWN	TM	08/10/2020
	CHECKED	OR	03/02/2022
DIMENSIONS ARE IN MM	THIRD AN	ICI E DDC	LICTION

1645 LEMONWOOD DR. SANTA PAULA, CA 93060

NEXT ASSEMBLY

5260168

5260630

5260632

5260652

THIRD ANGLE PROJECTION	

LOW RISE WHEELED POWER UNIT STAND ASSEMBLY

SIZE DWG. NO. REV С 5215983 **SCALE: 1:5** SHEET 1 OF 1

NOTE: UNLESS OTHERWISE SPECIFIED.


WHERE USED LR-60P

> MD-6XP DLR-6P


DMR-6

- REFER TO MODEL FOR ADDITIONAL INFORMATION SEE SHIPPING INSTRUCTIONS FOR FINAL PACKAGING

PROPRIETARY AND CONFIDENTIAL
THE INFORMATION CONTAINED IN THIS DRAWING IS
THE SOLE PROPERTY OF BENDFAK INC. ANY
REPRODUCTION IN PART OR AS A WHOLE WITHOUT
THE WRITTEN PERMISSION OF BENDPAK INC. IS
PROHIBITED.

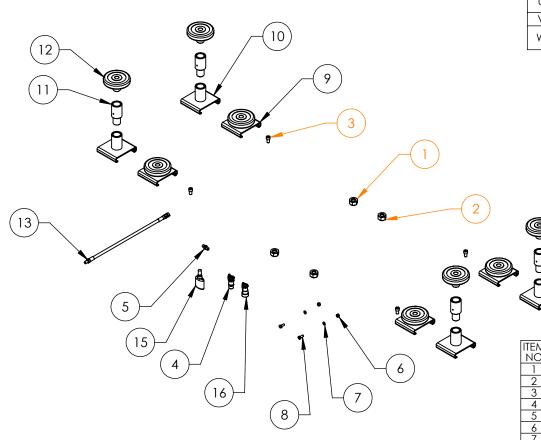

	REVISION							
REV	DESCRIPTION	DATE	EDITED BY	ECO#				
U	REMOVED (2) 5530304, (2) 5535001, AND (2) 5545202	09/24/2019	CA	01128				
V	ADDED 5580012	03/31/2020	TM	01152				
W	ADDED 5530031, REPLACED 5550103 WITH 5550413, REPLACED 5570013 WITH 5570245	08/11/2020	TM	01188				

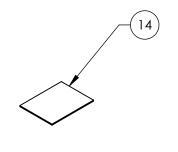

	ITEM NO	PART NUMBER	DESCRIPTION	QTY	REV
Ì	1	5545343	WASHER, M20 FLAT	4	-
Ī	2	5535017	NUT M20 x 2.5 NL	4	-
	3	5530336	SHCS M12 x 1.75 x 20	4	-
	4	5550413	FTG NPL -06 ORB x 1/4 NS; QUICK-CON COUP MALE	1	В
	5	5550147	FTG NPL -04 JIC x -04 NPT	1	-
	6	5535001	NUT M8 x 1.25 NL	2	-
	7	5545202	WASHER M8 x Ø15 SL	2	-
	8	5530304	HHB M8 x 1.25 x 20	2	-
	9	5215523	MD-6XP/P9000/RBJ4500 SHORT ROUND LIFT PAD ASSEMBLY	4	G
ı	10	5600257	MD-6XP/P9000/RBJ4500 LIFT PAD WELDMENT BASE	4	D
	11	5746390	MEDIUM LIFT PAD EXTENSION Ø35 x 113mm	4	Е
	12	5215507	ROUND LIFT PAD ADAPTER ASSEMBLY	4	G
	13	5570245	HYDRAULIC HOSE ASSEMBLY Ø6.4 x 3660mm DS-M	1	Α
	14	5900108	MD-6XP INSTALLATION MANUAL	1	-
	15	5580012	LIQUID PTFE THREAD SEALANT 50ml	1	-
	16	5550031	FTG NPL-04 NPT F x 1/4 QUICK-CONNECTOR COUPLER FEMALE: NON SPILL DESIGN	1	В

DO NOT SCALE DRAWING NAME DATE DRAWN TM 02/18/2009 1645 LEMONWOOD DR. SANTA PAULA, CA 93060 CHECKED DIMENSIONS ARE IN MM THIRD ANGLE PROJECTION TITLE: MD-6XP PARTS BOX SIZE DWG. NO. REV PROPRIETARY AND CONFIDENTIAL
THE INFORMATION CONTAINED IN THIS BRAWING IS
THE SOCIE PROPERTY OF BENDRA'S INC. ANY
THE WRITTEN PERMISSION OF BENDRA'S INC. IS
PROHISTEN PERMISSION OF BENDRA'S INC. IS 5250128 W

SCALE: 1:18


SHEET 1 OF 1

WHERE USED MD-6XP

NOTE: UNLESS OTHERWISE SPECIFIED.

SEE SHIPPING INSTRUCTIONS FOR FINAL PACKAGING

NEXT ASSEMBLY 5260169

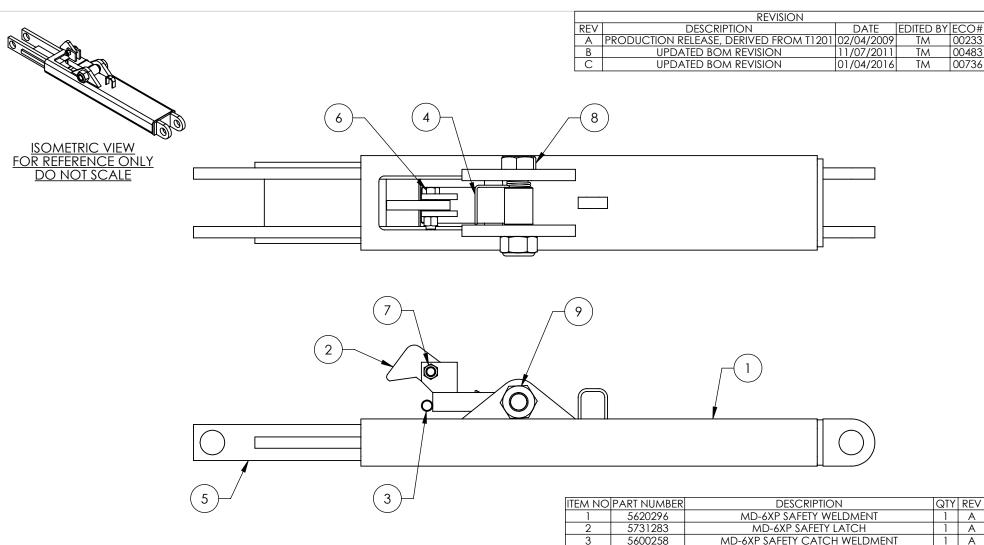

WHERE USED MD-6XP

NOTE: UNLESS OTHERWISE SPECIFIED.

- REFER TO MODEL FOR ADDITIONAL INFORMATION SEE SHIPPING INSTRUCTIONS FOR FINAL PACKAGING
- 2. 3. ASSEMBLE ITEMS AS SHOWN

NEXT ASSEMBLY 5245128

IIIEM NO	LAKI NOWREK	DESCRIPTION	Q Y	KEV
1	5620296	MD-6XP SAFETY WELDMENT	1	Α
2	5731283	MD-6XP SAFETY LATCH	1	Α
3	5600258	MD-6XP SAFETY CATCH WELDMENT	1	Α
4	5540016	MD-6XP SAFETY SPRING	1	В
5	5620099	MD-6XP SAFETY STOP WELDMENT	1	В
6	5530760	HHB M10 x 1.5 x 38	1	-
7	5535013	NUT M10 x 1.5 NL	1	-
8	5530041	HHB M20 x 2.5 x 90 CL10.9	1	-
9	5535017	NUT M20 x 2.5 NL	1	-

DATE



DO NOT SCALE DRAWING

PROPRIETARY AND CONFIDENTIAL
THE INFORMATION CONTAINED IN THIS DRAWING IS
THE SOLE PROPERTY OF BENDFAK INC. ANY
REPRODUCTION IN PART OR AS A WHOLE WITHOUT
THE WRITTEN PERMISSION OF BENDPAK INC. IS
PROHIBITED.


NAME

MD-6XP SAFETY **ASSEMBLY** SIZE DWG. NO. REV 5215253 С

1645 LEMONWOOD DR. SANTA PAULA, CA 93060

SCALE: 1:4

SHEET 1 OF 1

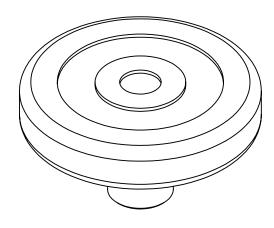


ISOMETRIC VIEW FOR REFERENCE ONLY DO NOT SCALE

WHERE	USED
QUICKJACK SERIES	MAXJAX
P9000 SERIES	D2-10 SERIES
MD-6XP	DMR-6
DMR-6	D2-8F
SP-7XE SERIES	HD-7BXT ACCY
GP-7 SERIES	
RJ-45LP	
RJW SERIES	
RBJ7000A	

NOTE: UNLESS OTHERWISE SPECIFIED.

- SEE SHIPPING INSTRUCTIONS FOR FINAL PACKAGING ASSEMBLE ITEMS AS SHOWN
- 2.

	REVISION							
REV	DESCRIPTION	DATE	EDITED BY	ECO#				
E E-001 E-002 E-003 E-004 E-005 E-006 E-007 E-008	UPDATE BOM REVISION AND NEXT ASSEMBLY UPDATED NEXT ASSEMBLY UPDATED NEXT ASSEMBLIES UPDATED NEXT ASSEMBLIES UPDATED NEXT ASSEMBLIES UPDATED NEXT ASSEMBLY UPDATED NEXT ASSEMBLIES UPDATED NEXT ASSEMBLIES UPDATED NEXT ASSEMBLY UPDATED NEXT ASSEMBLY	12/19/2012 03/14/2013 06/21/2013 10/16/2014 03/24/2015 08/06/2015 11/24/2016 01/21/2016 05/25/2017	MR JM TM	00572 00586 00605 00663 00691 00715 00738 00739 00833				
E-009	UPDATED NEXT ASSEMBLY	09/12/2017	TM	00867				
F	UPDATED BOM REVISION	02/02/2018	TS	00922				
G	UPDATED BOM REVISION AND NEXT ASSEMBLY	05/31/2018	TM	00953				

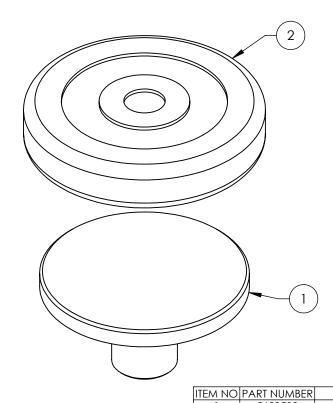


	1	560058	8	ROUND LIFT PAD WELDMENT					1	C
	2	571501	7	ROU	ND LIFT	PAD ADA	\PTE	R POLYURETHANE PAD	1	Е
NEVE ACCELUDIN	DO NOT SC	ALE DRAWING			NAME	DATE	-	Bonde		
NEXT ASSEMBLY 5150561 5250273			DR	AWN	AC	12/30/2010	_	P BendP		
5210163 5250273	-		СПЕ	CKFD	CA	06/18/2018		1645 LEMONWOOD DR. SANTA PAULA, CA 93060		
5210194 5250293	DIMENSION	IMENSIONS ARE IN MM				, . ,	TITL C	, , , , , , , , , , , , , , , , , , , ,		
5210214 5250297	DIMENSION			IHIKD AI	NGLE PRO	DJECTION	TITLE: ROUND LIFT PAD			
<u>5215865</u> <u>5250298</u>				ADAPTER ASS				ADAPTER ASSEMB	MBLY	
5215866 5250316	/	•)		4						
5216062		ار					SIZE	DWG. NO.	R	REV
5250080 5250328					Y AND CONF		Δ	5215507	- (G
5250115 5250331			THE SOI	E PROPERTY	OF BENDPAK	THIS DRAWING IS INC. ANY WHOLE WITHOUT	۲`	32.3337		•
5250128 5250373 5250271 5250374	-			ITTEN PERMIS	SION OF BEN E			SCALE: 1:2	SHEET 1	OF 1
32302/ T 32303/ T								0 07 (221 112		

DESCRIPTION

QTY REV

	REVISION			-
REV	DESCRIPTION	DATE	EDITED BY	ECO#
Α	PRODUCTION RELEASE	01/25/2008	AC	00142
B B-001	UPDATED DRAWING TO NEW STANDARDS AND TITLE UPDATED NEXT ASSEMBLY	02/19/2009 03/07/2011	TM TM	00233 00443
С	REPLACED 5570110 WITH 5570129 UPDATED NEXT ASSEMBLY	09/21/2015	JM	00726
C-001	UPDATED NEXT ASSEMBLY	04/13/2016	TM	00755

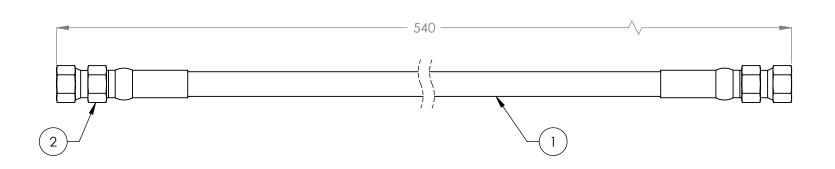

WHERE USED	
DMR-6	
MD-6XP	

NOTE: UNLESS OTHERWISE SPECIFIED.

FOR ITEM 1 SPECIFICATIONS REFER TO PART SPECIFICATION FORM (*)ITEM 1 QTY FOR REFERENCE ONLY

2.

		SURFACE
	NEXT ASSEMBLY	FOR MAC UNLESS O
	5260630	
ĺ	5260652	

ITEM NO	PARTN	IUMBER		DESCRIPTION			QTY	REV
1	5570	0129	Ø	Ø6.4 ID HYDRAULIC HOSE			474mm*	-
2	5550	0325	FTG	FTG NPL Ø1/4 CRIMP x -04 JIC			2	-
DO NOT SCALE DRAWING		NAME	DATE					

DRAWN AC 01/18/2008 CHECKED DB 06/23/2016 DIMENSIONS ARE IN MM TOLERANCES: THIRD ANGLE PROJECTION 0. = ± 1.5 0.0 = ± 1.0 0.00 = ± 0.25 0.000 = ± 0.13 FINISH 1.6 ISO Ra µm CHINED SURFACES OTHERWISE SPECIFIED

HYDRAULIC HOSE ASSEMBLY Ø6.4 x 540mm DS

1645 LEMONWOOD DR. SANTA PAULA, CA 93060

SIZE DWG. NO. PROPRIETARY AND CONFIDENTIAL
THE INFORMATION CONTAINED IN THIS DRAWING IS
THE SOLE PROPERTY OF BENDFAK INC. ANY
REPRODUCTION IN PART OR AS A WHOLE WITHOUT
THE WRITTEN PERMISSION OF BENDPAK INC. IS
PROHIBITED. **SCALE: 1:2**

REV 5570054 C SHEET 1 OF 1



PART SPECIFICATION FORM ACP

BENDPAK Number:	5570129
MRP Description:	1/4" HYDRAULIC HOSE 31 CL-0400X
Date:	05/24/2018
ECO:	00950

1. Engineering Specification

Application:

1/4" HYDRAULIC HOSE

Detailed Description:

ONE or TWO BRAID STEEL WIRE HYDRAULIC HOSE

SIZE: 1/4" / 6mm I.D. MIN

0.53" / 13.4mm O.D. MAX

SPECS: 5700PSI OR 393 BAR WORKING PRESSURE MINIMUM

17100PSI OR 1179 BAR MINIMUM BURST PRESSURE MINIMUM

3" / 80mm MIN BEND RADIUS

COLOR: BLACK

ADDITIONAL CONTACT INFORMATION:

Xin Yurong

Shandong Ningjin High Energy Hose Co., Ltd.

Tel: +86 534-5421821

No. 7, Taishan Rd., Industrial Park, Ningjin County, Shandong, China




2. Vendor Information (Or for Reference)

Approved Vendor	Vendor Part #	Contact #	AUTHORIZED COMPONENT PROVIDER
1) Ningjin Hydraulic Hose Co.	5570129	+86 534-5421821	х
2)			

OR BENDPAK ENGINEERING APPROVED EQUIVALENT

REVISION						
REV	DESCRIPTION	DATE	EDITED BY	ECO#		
Α	PRODUCTION RELEASE, DERIVED FROM 5570233	08/11/2020	TM	01188		

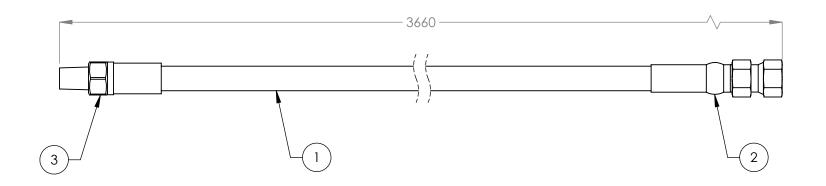

WHERE USED MD-6XP DMR-6

NOTE: UNLESS OTHERWISE SPECIFIED.

FOR ITEM 1 SPECIFICATIONS REFER TO PART SPECIFICATION FORM (*)ITEM 1 QTY FOR REFERENCE ONLY

2.

		SUR
ĺ	NEXT ASSEMBLY	ÜÑI
	5250128	
Ì	5250316	

ITEM NO.	PART NUMBER	DESCRIPTION	QTY.	REV
1	5570129	Ø6.4 ID HYDRAULIC HOSE	3598mm*	-
2	5550325	FTG NPL Ø1/4 CRIMP x -04 JIC	1	-
3	5550060	FTG NPL Ø1/4 CRIMP x -04 NPT M	1	-

DO NOT SCALE DRAWING NAME DATE DRAWN TM 08/11/2020 CHECKED DIMENSIONS ARE IN MM THIRD ANGLE PROJECTION TOLERANCES: 0. = ± 1.5 0.0 = ± 1.0 0.00 = ± 0.25 0.000 = ± 0.13 IRFACE FINISH 1.6 ISO Ra µm OR MACHINED SURFACES NLESS OTHERWISE SPECIFIED PROPRIETARY AND CONFIDENTIAL
THE INFORMATION CONTAINED IN THIS DRAWING IS
THE SOLE PROPERTY OF BENDFAK INC. ANY
REPRODUCTION IN PART OR AS A WHOLE WITHOUT
THE WRITTEN PERMISSION OF BENDPAK INC. IS
PROHIBITED.


1645 LEMONWOOD DR. SANTA PAULA, CA 93060 HYDRAULIC HOSE ASSEMBLY

Ø6.4 x 3660mm DS-M SIZE DWG. NO. REV

5570245

Α

SCALE: 1:5 SHEET 1 OF 1

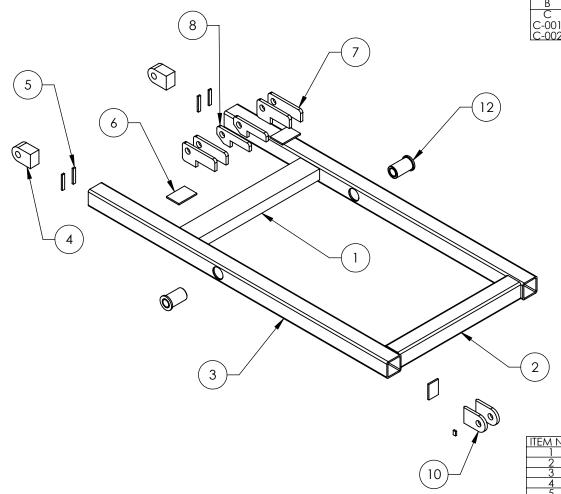

	REVISION			
REV	DESCRIPTION	DATE	EDITED BY	ECO#
Α	PRODUCTION RELEASE, DERIVED FROM T1 193	02/03/2009	TM	00233
В		09/22/2011	TM	00483
С	ADDED 6mm WELD TO 5215222	04/09/2013	TM	00598
C-001	CHANGE PAINT COLOR TO GREY	08/03/2017	TS	00861
C-002	ADDED 20% GLOSS PAINT NOTE	08/12/2020	TM	01188

DESCRIPTION MD-6XP CROSS BAR MD-6XP INNER ARM CROSS TUBE QTY REV ITEM NO PART NUMBER 5735451 Α 5766065 5766068 Α MD-6XP INNER ARM TUBE Α 5766068 5731048 5735453 5735452 5731047 5736176 5736224 5736225 5735028 5215222 MD-6XP INNER ARM 10BE
MD-6XP INNER ARM CONNECTOR
MD-6XP ARM EAR SUPPORT
MD-6XP CYLINDER BRACKET SUPPORT
MD-6XP CYLINDER BRACKET
MD-6XP SAFETY CLEVIS
MD-6XP TUBE END PLATE B 2 4 2 4 2 2 A Α Α A B MD-6XP ARM ROLLER EAR 4 PIN STOP MD-6XP BUSHING ASSEMBLY NAME DATE

DO NOT SCALE DRAWING

DIMENSIONS ARE IN MM TOLERANCES: 0. = ±1.5 0.0 = ±0.5

SURFACE FINISH 1.6 ISO Ra µm FOR MACHINED SURFACES UNLESS OTHERWISE SPECIFIED

02/03/2009 CHECKED THIRD ANGLE PROJECTION TITLE:

DRAWN

MD-6XP INNER ARM WELDMENT REV

1645 LEMONWOOD DR. SANTA PAULA, CA 93060

SIZE DWG. NO. PROPRIETARY AND CONFIDENTIAL
THE INFORMATION CONTAINED IN THIS DRAWING IS
THE SOLE PROPERTY OF BENDPAK INC. ANY
REPRODUCTION IN PART OR AS A WHOLE WITHOUT
THE WRITTEN PERMISSION OF BENDPAK INC. IS
PROHIBITED.

5600238

SHEET 1 OF 3 SCALE: 1:14

С

NOTE: UNLESS OTHERWISE SPECIFIED.

- REFER TO MODEL FOR ADDITIONAL INFORMATION
- 2. BREAK AND DEBURR ALL SHARP EDGES 0.3mm
- 3. REMOVE ALL WELD SPLATTER


WHERE USED

MD-6XP

- DIMENSIONS SHOWN ARE AFTER PAINTING 4.
- 5. PAINT GRAY (RAL-7024) 20% GLOSS

NEXT ASSEMBLY 5245128

	REVISION			
REV	DESCRIPTION	DATE	EDITED BY	ECO#
В	UPDATED BOM REVISIONS	11/08/2011	TM	00483
С	UPDATED BOM REVISIONS	04/09/2013	TM	00598
D	CHANGED PAINT COLOR TO GREY, UPDATED	08/03/2017	TS	00861
	BOM REVISIONS			
D-001	ADDED 20% GLOSS PAINT NOTE	08/12/2020	TM	01188

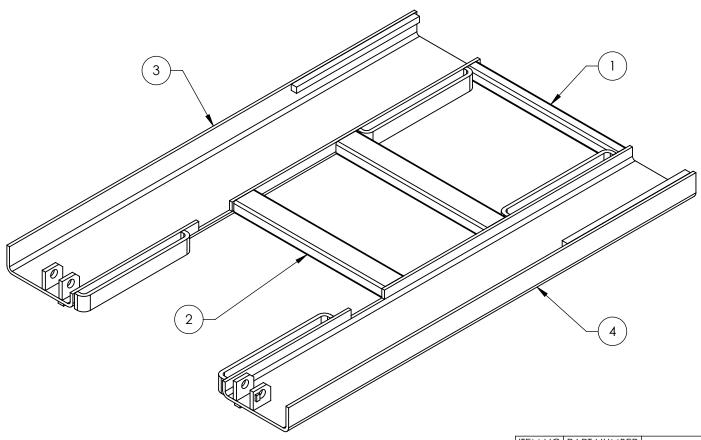

WHERE USED MD-6XP

NOTE: UNLESS OTHERWISE SPECIFIED.

- 1. REFER TO MODEL FOR ADDITIONAL INFORMATION
- 2. BREAK AND DEBURR ALL SHARP EDGES 0.3mm
- 3. REMOVE ALL WELD SPLATTER
- 4. DIMENSIONS SHOWN ARE AFTER PAINTING
- 5. PAINT GRAY (RAL-7024) 20% GLOSS

	UNU	PART NUMBER	DESCRIPTION	QTY	REV
1	1	5765024	MD-6XP COVER WELDMENT TIE-IN TUBE	1	Α
2	2	5765025	MD-6XP COVER CROSS TUBE	2	Α
3	3	5620298	MD-6XP RIGHT COVER RAMP WELDMENT	1	D
	4	5620299	MD-6XP LEFT COVER RAMP WELDMENT	1	D
4	4	5620299	MD-6XP LEFT COVER RAMP WELDMENT		1

DO NOT SCALE DRAWING

DRAWN

TM

02/04/2009

CHECKED

DIMENSIONS ARE IN MM
TOLERANCES:
0.0 = ±1.5
0.0 = ±0.5
SURFACE FINISH 1.6 ISO RQ µm
FOR MACHINED SURFACES
UNLESS OTHERWISE SPECIFIED

1645 LEMONWOOD DR.
SANTA PAULA, CA 93060

TITLE:

MD-6XP COVER WELDMENT

PROPRIETARY AND CONFIDENTIAL
THE INFORMATION CONFIDENTIAL
THE INFORMATION CONFIDENTIAL
THE INFORMATION TO STANKED IN THE DRAWING IS
THE SOCIEMATION IN PAST OR AS A WHOLE WITHOUT
THE WRITTEN PERMISSION OF BENDPAKINC.


SCALE: 1:10

5600239 D

REV

NEXT ASSEMBLY 5245128

	REVISION			
REV	DESCRIPTION	DATE	EDITED BY	ECO#
Α	PRODUCTION RELEASE, DERIVED FROM T1200	02/04/2009	TM	00233
В	UPDATED BOM REVISIONS	02/15/2013	TM	00579
B-001	CHANGED PAINT COLOR TO GREY	08/03/2017	TS	00861
B-002	ADDED 20% GLOSS PAINT NOTE	08/12/2020	TM	01188
C	UPDATED BOM REVISION	06/03/2021	OR	01306

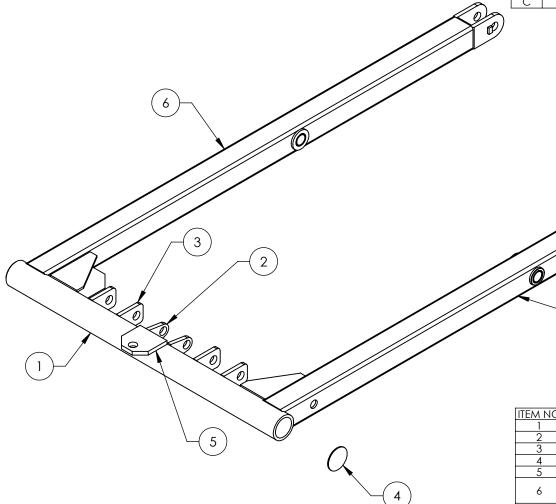

ITEM NO	PART NUMBER	DESCRIPTION		REV
1	1 5735136 DMR-6/MD-6XP BOTTOM BAR		1	Α
2	5731049	DMR-6/MD-6XP SAFETY MOUNTING BRACKET	2	Α
3	5731050	DMR-6/MD-6XP CYLINDER MOUNTING BRACKET	4	Α
4	5736227	DMR-6/MD-6XP BOTTOM BAR END COVER	2	Α
5	5736182	DMR-6/MD-6XP TOW CART CONNECTOR	1	Α
6	5620302	DMR-6/MD-6XP LEFT OUTER SCISSOR ARM WELDMENT	1	С
7	5620307	DMR-6/MD-6XP RIGHT OUTER SCISSOR ARM WELDMENT	1	С

WHERE USED MD-6XP

NOTE: UNLESS OTHERWISE SPECIFIED.

- REFER TO MODEL FOR ADDITIONAL INFORMATION
- BREAK AND DEBURR ALL SHARP EDGES 0.3mm REMOVE ALL WELD SPLATTER
- 2.
- DIMENSIONS SHOWN ARE AFTER PAINTING PAINT GRAY (RAL-7024) 20% GLOSS 4.
- 5.


DIMENSIONS ARE IN MM TOLERANCES: 0. = ±1.5 0.0 = ±0.5 SURFACE FINISH 1.6 ISO Ra µm FOR MACHINED SURFACES UNLESS OTHERWISE SPECIFIED

DO NOT SCALE DRAWING


NEXT ASSEMBLY

5245128

		NAME	DATE	BP BendP				
	DRAWN	TM	02/04/2009		Delia			
	CHECKED				1645 LEMONWOOD DR SANTA PAULA, CA 9306			
THIRD ANGLE PROJECTION			DJECTION	TITLE	MD-6XP OUTER WELDMENT		RM	
	Т			SIZE	DWG. NO.		REV	
	PROPRIETAR THE INFORMATION OF THE SOLE PROPERTY REPRODUCTION IN P	OF BENDPAK	I THIS DRAWING IS INC. ANY	Α	5600240		С	
	THE WRITTEN PERMISS PROHIBITED.				SCALE: 1:10	SHE	EET 1 OF 3	

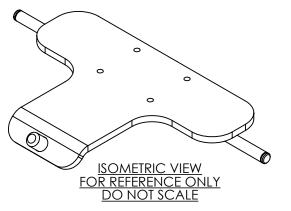

	REVISION			
REV	DESCRIPTION	DATE	EDITED BY	ECO#
Α	PRODUCTION RELEASE, DERIVED FROM 5600187	09/12/2019	TM	01128 -PRE
A-001	ADDED 20% GLOSS PAINT NOTE	08/11/2020	TM	01188
В	REMOVED 5746130, WAS 55 NOW 45, UPDATED COLOR, WAS GRAY NOW BLACK, UPDATED BOM REVISIONS	07/15/2021	СА	01317

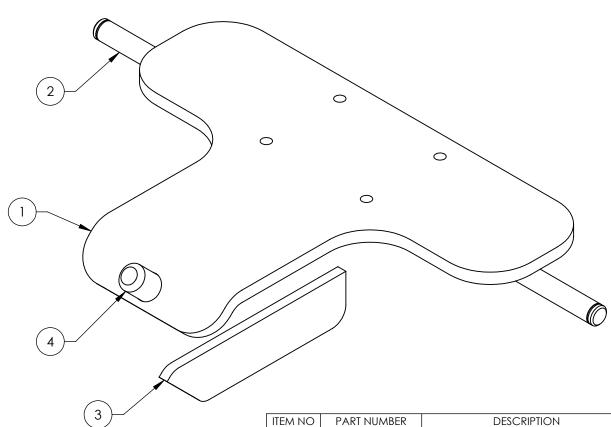

NEXT ASSEMBLY

5215871

WHERE USED
LR-60P
MD-6XP
DMR-6
DLR-6P

NOTE: UNLESS OTHERWISE SPECIFIED.

- 1. REFER TO MODEL FOR ADDITIONAL INFORMATION
- 2. BREAK AND DEBURR ALL SHARP EDGES 0.3mm
- 3. REMOVE ALL WELD SPLATTER
- 4. DIMENSIONS SHOWN ARE AFTER PAINTING
- 5. PAINT BLACK (RAL-9017) 20% GLOSS

ITEM NO	PART NUMBER	DESCRIPTION	QTY	REV
1	5730083	LOW RISE TOW CART BASE PLATE	1	В
2	5746122	LOW RISE TOW CART AXLE	1	В
3	5737140	LOW RISE TOW CART SUPPORT BAR	1	В
4	5746129	LOW RISE TOW CART PIN	1	С

DO NOT SCALE DRAWING

DRAWN

TM

09/12/2019

CHECKED

OR

07/22/2021

THIRD ANGLE PROJECTION

TITLE:

SURFACE FINISH 1.6 SOR BUT FOR MACHINED SURFACES
UNLESS OTHERWISE SPECIFIED

DIMENSIONS ARE IN MM

TOLERANCES:

SURFACE FINISH 1.6 SOR BUT FOR MACHINED SURFACES
UNLESS OTHERWISE SPECIFIED

21 1645 LEMONWOOD DR.
SANTA PAULA, CA 93060

TITLE: LOW RISE TOW CART
BASE WELDMENT

SIZE DWG. NO. REV


BendPak.

THE INFORMATION CONTIDENTIAL


THE INFORMATION CONTAINED IN THIS DRAWING IS
THE SOLE PROPERTY OF BENDPAK INC. ANY
REPRODUCTION IN PART OR AS A WHOLE WITHOUT
THE WRITEN PERMISSION OF BENDPAK INC. IS

5601405 SCALE: 1:2

B SHEET 1 OF 2

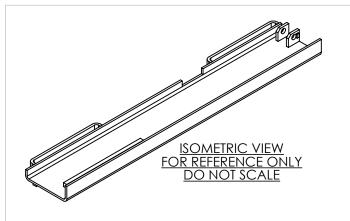

	REVISION			
REV	DESCRIPTION	DATE	EDITED BY	ECO#
В	5700251 WAS FLUSH NOW 6mm DISTANCE	11/07/2011	TM	00483
С	5730043 DISTANCE WAS 47 NOW 51	04/09/2013	TM	00598
D	MOVED 5735028 TO OPPOSITE SIDE IN TWO PLACES	08/03/2017	TS	00861

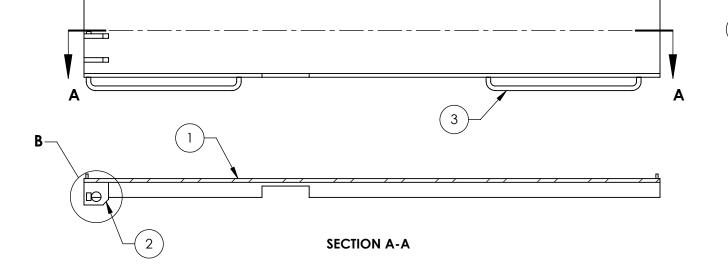

DETAIL B

SCALE 1:4



02/03/2009

MD-6XP
DMR-6

NOTE: UNLESS OTHERWISE SPECIFIED.

- 1. REFER TO MODEL FOR ADDITIONAL INFORMATION
- 2. BREAK AND DEBURR ALL SHARP EDGES 0.3mm
- 3. REMOVE ALL WELD SPLATTER

	SURFACE FINISH 1.6 ISO Ra µm FOR MACHINED SURFACES UNLESS OTHERWISE SPECIFIED
NEXT ASSEMBLY	
5600239	
5601554	

	CHECKED	AW	8/14/2017		S
	THIRD AN	IGLE PRO	DJECTION	TITLE	
m				(DMI COVE
				SIZE	DWG. 1
)	PROPRIETAR THE INFORMATION C THE SOLE PROPERTY REPRODUCTION IN P	OF BENDPAK	THIS DRAWING IS INC. ANY	A	
	THE WRITTEN PERMISS PROHIBITED.				SC

DRAWN

DIMENSIONS ARE IN MM TOLERANCES:

0. = ±1.5 0.0 = ±0.5 1645 LEMONWOOD DR.
SANTA PAULA, CA 93060

TITLE:

DMR-6/MD-6XP RIGHT


COVER RAMP WELDMENT

SIZE DWG. NO.

SIZE DWG. NO. 5620298

SCALE: 1:10

D SHEET 1 OF 2

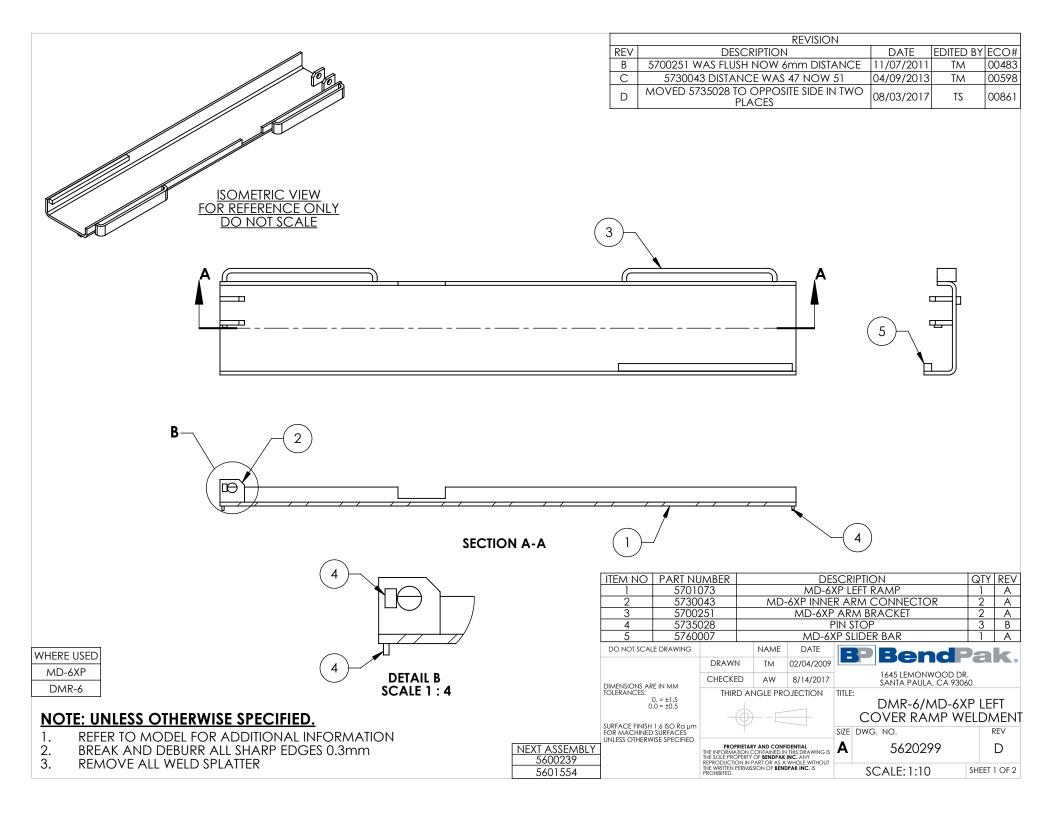



PART SPECIFICATION FORM (STANDARD)

BENDPAK Number:	5900108
MRP Description:	MD-6XP INSTALLATION MANUAL
Date:	04/27/2021
ECO:	

1. Engineering Specification

Application:

INSTALLATION MANUAL

Detailed Description:


Print Settings for BendPak Manuals:

Unless otherwise specified, use these settings for printing BendPak manuals:

- Color: Black and white.
- Size: A4 (210 to 297 mm), 8.5 by 11 inches (216 to 279 mm), or between
- Binding: Saddle stitched
- Paper: 100 to 120 gsm (27 to 32 pound), uncoated.





2. Vendor Information (Or for Reference)								
Approved Vendor	Vendor Part #	Contact #	Preferred Vendor					
1)								
OR BENDPAK ENGINEERING APPROVED EQUIVALENT								

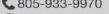





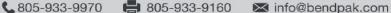

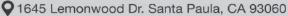













PN 5905204

Clear PET material and

SHOULD NOT print as Yellow



BPBendPak

MD-6XP_BendPak_Cylinder_Decal.pdf:

Material: Clear Adhesive PET

Size: 16"W x 3"H

Thickness: 4 Mil

Finish: Matte Overlaminate (No gloss)
Ink: U.V. protected, Opaque White

Print Process: Silk Screen, 85 line-screen (Yellow color in file represents what should be clear PET material and SHOULD NOT print as Yellow ink. White area in file represents Opaque White ink.)

Lamination: Clear laminate non-glare medium matte over-laminate (No gloss) for abrasion, chemical and ultra violet protection.

B



PN 5905940

Product_Data_Label_5905940-New.pdf:

Size: 4.5"W x 2.3"H

Material: 4 Mil. Permanent White Adhesive Vinyl

Thickness: 4 Mil


Ink: U.V. protected CMYK 2/C Process

Finish: Matte Overlaminate (No gloss)

Print Process: Offset Lithography - 200 line-screen or 300 p.p.i. for digital

Lamination: Clear laminate non-glare medium matte over-laminate (No gloss) for abrasion, chemical and ultra violet protection.



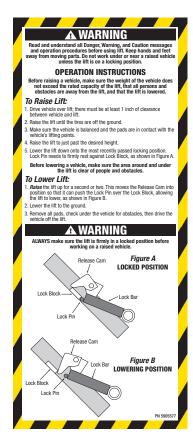

PN 5905577

 $Warning_Operation_Inst_Label_5905577.pdf:$

Size: 3.5"W x 8.25"H

Material: 4 Mil. Permanent White Adhesive Vinyl

Thickness: 4 Mil

Ink: U.V. protected CMYK 2/C Process

Finish: Matte Overlaminate (No gloss)

Print Process: Offset Lithography - 200 line-screen or 300

p.p.i. for digita

Lamination: Clear laminate non-glare medium matte overlaminate (No gloss) for abrasion, chemical and ultra violet protection.



PN 5905576

Warning_Drive_Car_Over_Label_5905576.pdf:Size: 3.5"W x 11"H

Material: 4 Mil. Permanent White Adhesive Vinyl

Thickness: 4 Mil

Ink: U.V. protected CMYK 2/C Process

Finish: Matte Overlaminate (No gloss)

Print Process: Offset Lithography - 200 line-screen or 300 p.p.i. for digital

Lamination: Clear laminate non-glare medium matte over-laminate (No gloss) for abrasion, chemical and ultra violet protection.





PN 5905176

$Scissor_Cylinder_Warning-Red_FRE-ENG-5905176.pdf:$

Size: 3"W x 5.25"H

Material: 4 Mil. Permanent White Adhesive Vinyl

Thickness: 4 Mil

Ink: U.V. protected CMYK 2/C Process

Finish: Matte Overlaminate (No gloss)

Print Process: Offset Lithography - 200 line-screen or 300

p.p.i. for digital

Lamination: Clear laminate non-glare medium matte overlaminate (No gloss) for abrasion, chemical and ultra violet protection





PN 5905951

2020_Serial_Tag-B-5905951.jpg:

Size: 3"W x 3"H

Material: Material: 2 Mil. Matte Silver Polyester

(Flex-PSE)

Print using thermal transfer printer with resin ribbon

Ink: 1 Color-Black

E

Hazard Decals on left and right side of the platforms



Material: Vinyl Adhesive / Backing: Soft Polyvinyl Chloride

Thickness: 6.5 Mil

Finish: Matte Overlaminate (No gloss)





PN 5905138

Slippery_When_Wet_Label-5905138.pdf:

Size: 4.5"W x 2.5"H

Material: 4 Mil. Permanent White Adhesive Vinyl

Thickness: 4 Mil

Ink: U.V. protected CMYK 2/C Process

Finish: Matte Overlaminate (No gloss)

Print Process: Offset Lithography - 200 line-screen or 300

p.p.i. for digital

Lamination: Clear laminate non-glare medium matte overlaminate (No gloss) for abrasion, chemical and ultra violet protection.



NOTE: DIE-CUT TO SHAPE

American_Owned_50_Years_Logo.pdf:

Trim: 3"W x 4"H


Material: 4 Mil. Permanent White Adhesive Vinyl

Ink: U.V. protected CMYK 4/C Process Finish: Matte Overlaminate (No Gloss)


Print Process: Offset Lithography - 200 line-screen or

300 p.p.i. for digital

Lamination: Clear Laminate non-glare medium matte over laminate for abrasion, chemical, and ultra violet protection

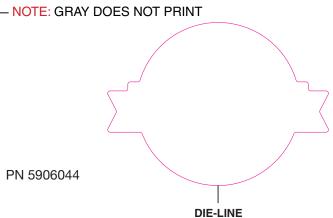



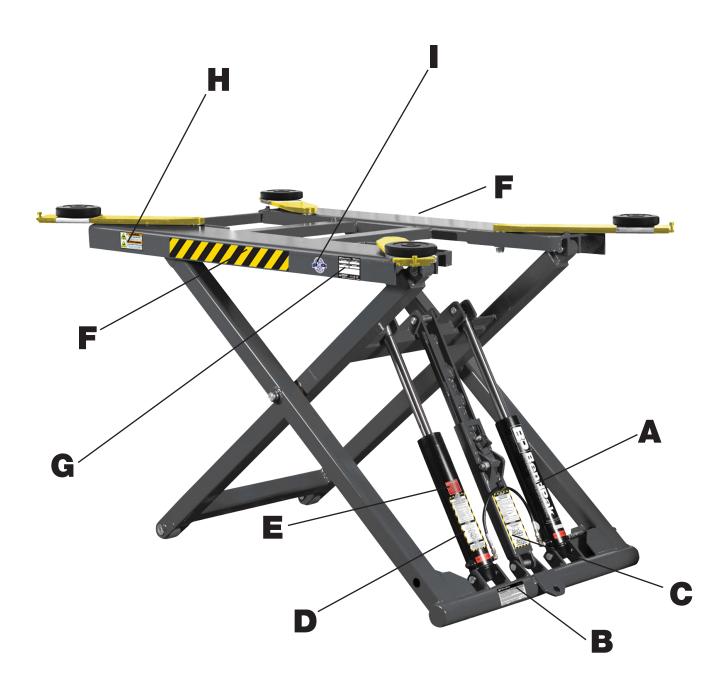

MD-6XP Carton Decal Positioning



MD-6XP Carton Label 5905966 REV REV:

Trim: 8.5"W x 5.5"H

Material: 4 Mil. Permanent White Adhesive Vinyl

Ink: U.V. protected CMYK 4/C Process

Print Process: Offset Lithography - 200 line-screen or 300 p.p.i.

for digita

PN 5905966

B



Manufacturer_Packaging_Label:

Trim: 6"W x 3.75"H

Material: 4 Mil. Permanent White Adhesive Vinyl

Ink: 1 Color-Black

Print Process: Offset Lithography - 200 line-screen or 300 p.p.i.

for digital

PN 5905465

C



PN 5905285

BPK_Serial_Tag_New-2017_Peel_Off-5905285.pdf:

Size: 3"W x 3"H

Material: 2 Mil. Gloss polyester thermal transfer label with a high performance permanent acrylic adhesive.

Ink: 1 Color-Black

D









RNGR_Carton_Handling_Tag.pdf:

Size: Size as needed to fit

Material: Prints on Carton Material

Ink: Process Black